
## SECTION 7 STANDARD DRAWING INDEX

DWG NO.	TITLE		
3305-001	TYPICAL TRENCH		
3305-002	SURFACE RESTORATION		
3305-710	TYPICAL BUILDING AND BASE MOUNTED SELF PRIMING PUMPING STATION WITH STANDBY ENGINE SECTIONAL ELEVATION		
3305-715	THRUST BLOCK NOTES AND DETAILS		
3305-720	AIR AND VACUUM VALVE ASSEMBLY		
3305-725	TYPICAL ACCESS ROAD		
3305-730	REDUCED PRESSURE PRINCIPAL BACKFLOW PREVENTOR		
3305-735	CHAIN LINK FENCE		
3305-740	YARD HOSE BIBB DETAILS		
3305-745	ILLUSTRATION OF NUMBER OF SERVICE LINES REQUIRED FOR HOUSE, GARDEN HOME, TOWN HOUSE, PATIO HOME OR DUPLEX		
3305-750	PRESSURE GAUGE MOUNTING DETAIL		
3305-760A	CONTROL PANEL MOUNTING DETAIL		
3305-760B	CONTROL PANEL MOUNTING DETAIL		
3305-765A	WASTE WATER SUBMERSIBLE LIFT STATION TOP PLAN		
3305-765B	WASTE WATER SUBMERSIBLE LIFT STATION FOUNDATION PLAN		
3305-765C	WASTE WATER SUBMERSIBLE LIFT STATION SECTION		

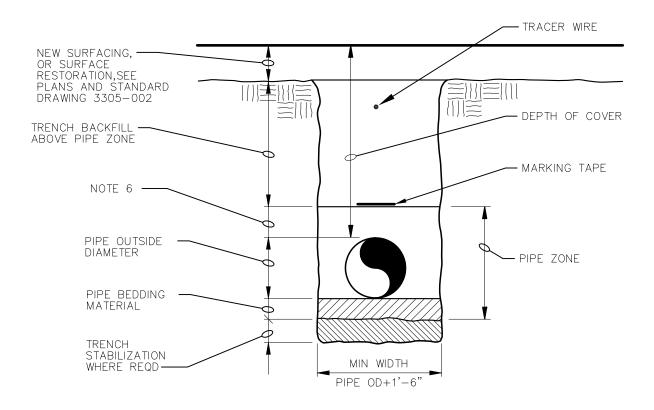


### NOTES:

- 1. CONTRACTOR SHALL SLOPE TRENCH WALLS OR SHORE EXCAVATIONS FOR CONSTRUCTION AND SAFETY AND IN ACCORDANCE WITH CURRENT OSHA REQUIREMENTS.
- 2. FOUNDATION STABILIZATION MATERIAL SHALL BE INSTALLED ONLY AS APPROVED AND DIRECTED BY THE ENGINEER AND IN ACCORDANCE WITH THE SPECIFICATION.
- 3. SEE SPECIFICATION SECTION 31 23 16 EXCAVATION AND 31 23 23 TRENCH BACKFILL.
- 4. COORDINATE LOCATION OF MARKING TAPE WITH SPECIFICATIONS. PROVIDE NEW SURFACING AS SHOWN ON THE DRAWINGS.
- 5. WHERE TRENCHES ARE IN AREAS NOT DESIGNATED TO RECEIVE NEW ASPHALT, GRAVEL OR PCC CONCRETE SURFACING, RESTORE EXISTING SURFACE USING SEED OR SOD AS DIRECTED.
- 6. MINIMUM DEPTH OVER PIPE IS BY SIZE AND SERVICE AS FOLLOWS:
  a. 4" AND 6" GRAVITY SERVICE: 6" MIN.
  b. 8" GRAVITY SERVICE AND LARGER AND ALL FORCE MAINS:

  - 12" MIN.
- 7. PROVIDE TRACER WIRE PER SPECIFICATION FOR ALL FORCE MAINS.

DATE	REVISIONS	JEFFERSON COUNTY ALABAMA
01/15	TEXT UPDATE	ENVIRONMENTAL SERVICES DEPARTMENT
		TYPICAL TRENCH
MAY 2015		
APPR	OVED:	STANDARD DRAWING NO. <u>3305-001</u>

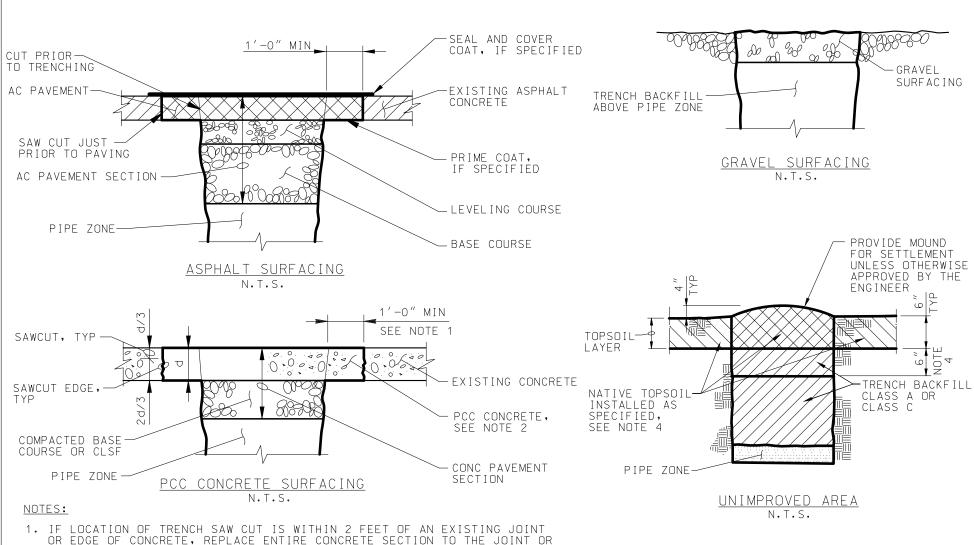


DATE

DEVICIONIC

- EDGE.
- 2. CONSTRUCT JOINTS ACROSS NEW CONCRETE TO MATCH EXISTING JOINT TYPES AND LOCATIONS.
- 3. SURFACE RESTORATION MUST BE COMPATIBLE WITH TYPE OF BACKFILL USED. COMPACTED CRUSHED ROCK AND LEVELING COURSE BASE SHOULD NOT BE PLACED ON NATIVE MATERIAL.
- 4. THE TOP 6" OF TRENCH BACKFILL, BENEATH THE TOPSOIL LAYER, SHOULD BE INSTALLED, SMOOTHED, BUT LEFT UN-COMPACTED.
- 5. TOPSOIL SHALL EXTEND BEYOND TOP OF TRENCH A MINIMUM OF 12".
- 6. SOD OR SEED AS DIRECTED.

DATE	REVISIONS	JEFFERSON COUNTY ALABAMA
01/15	TEXT UPDATE	ENVIRONMENTAL SERVICES DEPARTMENT
01/13	ILAT OF DATE	
		SURFACE RESTORATION
	MAY 2015	
ADDD	OVED:	STANDARD DRAWING NO. 3305-002
ALLIN	UVLD	

IEEEEDOONI OOLINITY ALADAMA

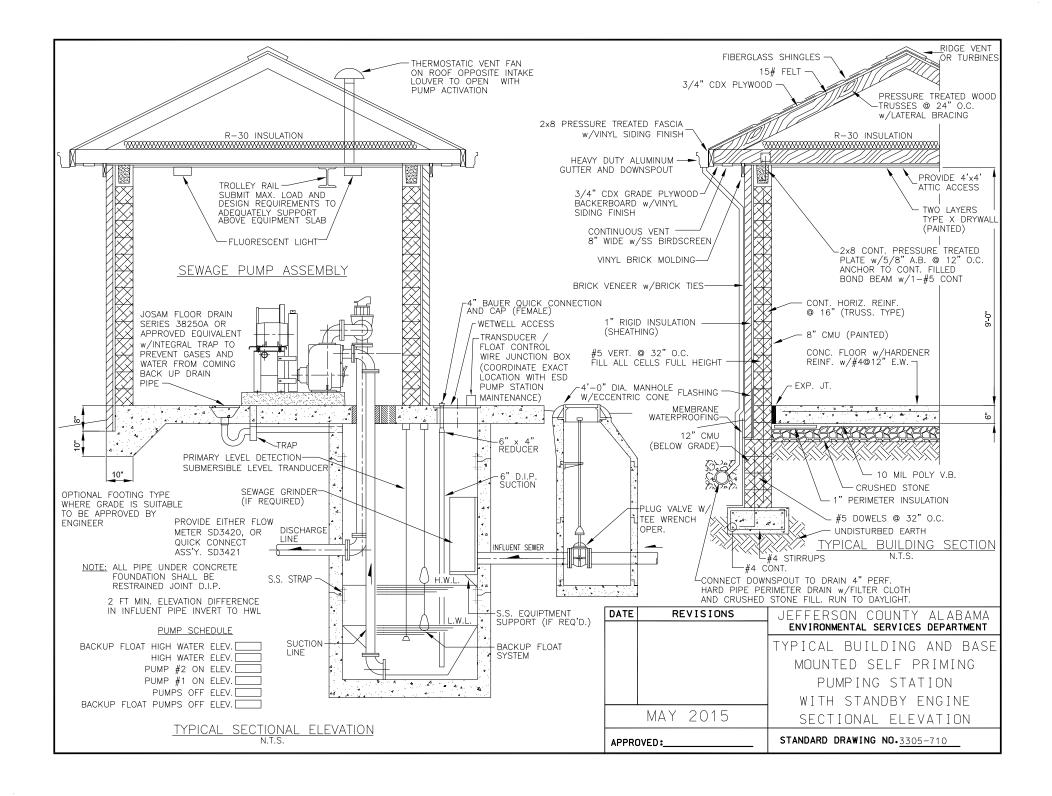

FITTING SIZE	ROD	EMBEDMENT
12" AND LESS	#6	30"

GALVANIZED RODS OVER FITTING AND EMBEDDED IN CONCRETE (SEE TABLE FOR SIZES)

PROFILE	

\* EACH AREA (A/2) IS 1/2 OF TABULATED TOTAL AREA

BEARING AREA OF THRUST BLOCKS IN SQ. FT. (HORIZONTAL BENDS)							
FITTING SIZE	TEE, WYE, PLUG, OR CAP	90° BEND PLUGGED CROSS	TEE PLUGGED RUN		BEND ANGLE		
	CAI	CINOSS	A 1	Α2	45°	22 1/2°	11 1/4°
4	1.0	1.4	1.9	1.4	1.0	_	_
6	2.1	3.0	4.3	3.0	1.6	1.0	_

7.6

11.8

17.0

5.4 | 2.9 | 1.5

8.4

12.0

4.6

6.6 3.4

2.4

5.3

8.4

12.0

8

10


12


3.8

5.9

8.5

(VERTICAL BENDS)				
FITTING	BEND ANGLE			
SIZE	45°	22 1/2°	11 1/4°	
4	1.1	0.4	0.2	
6	2.7	1.0	0.4	
8	4.0	1.5	0.6	
10	6.0	2.3	0.9	
12	8.5	3.2	1.3	

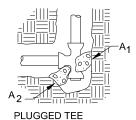


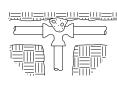

1.0

1.2

1.7

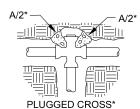

TEE

THRUST BLOCK NOTES


- KEEP CONCRETE CLEAR OF JOINT AND JOINT ACCESSORIES.
- 2. CONCRETE THRUST BLOCKING SHALL BE POURED AGAINST UNDISTURBED EARTH.
- 3. REQUIRED VOLUMES OR BEARING AREAS AT FITTINGS SHALL BE AS INDICATED BELOW, ADJUSTED, IF NECESSARY, TO CONFORM TO THE TEST PRESSURE(S) AND ALLOWABLE SOIL BEARING STRESS(ES) STATED IN THE SPECIFICATIONS.
- 4. THRUST BLOCK VOLUMES FOR VERTICAL BENDS HAVING UPWARD RESULTANT THRUSTS ARE BASED ON TEST PRESSURE OF 150 PSIG AND THE WEIGHT OF CONCRETE = 4050 LBS/CU YD. TO COMPUTE VOLUMES FOR DIFFERENT TEST PRESSURES, USE THE FOLLOWING EQUATION: VOLUME = (TEST PRESS./150) x (TABLE VALUE).
- 5. BEARING AREAS FOR HORIZONTAL BEND THRUST BLOCKS ARE BASED ON TEST PRESSURE OF 150 PSIG AND AN ALLOWABLE SOIL BEARING STRESS OF 2000 LBS/SQ FT. TO COMPUTE BEARING AREAS FOR DIFFERENT TEST PRESSURES AND SOIL BEARING STRESSES, MULTIPLY TABLE VALUES BY THE FACTOR (13.33)(P'/S'<sub>b</sub>), WHERE:

P' = ACTUAL TEST PRESSURE, PSIG S'<sub>b</sub>= ACTUAL SOIL BEARING PRESSURE, PSF.


- THRUST BLOCKS FOR VERTICAL BENDS HAVING DOWNWARD RESULTANT THRUSTS SHALL BE THE SAME AS FOR HORIZONTAL BENDS.
- 7. BEARING AREAS, VOLUMES, AND SPECIAL BLOCKING DETAILS SHOWN ON PLANS TAKE PRECEDENCE OVER THIS STANDARD
- 8. BEARING AREA OF THRUST BLOCK SHALL NOT BE LESS THAN 1.0 SQ FT.
- VERTICAL BENDS THAT REQUIRE A THRUST BLOCK VOLUME EXCEEDING 5 CUBIC YARDS REQUIRE SPECIAL BLOCKING DETAILS. SEE PLANS FOR VOLUMES SHOWN TO LEFT OF SOLID LINE IN TABLE.
- 10. TEST PRESSURES ARE SHOWN IN THE PIPING SCHEDULE.
- 11. ALLOWABLE SOIL BEARING STRESS IS 2000 LBS/SQ FT



BEND

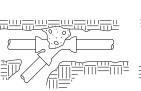



WYE

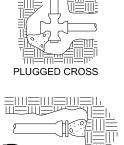

1/4" PLYWOOD OVER FACE OF BOLTS


DATE	REVISIONS	JEFFERSON COUNTY ALABAMA
		ENVIRONMENTAL SERVICES DEPARTMENT
		THRUST BLOCK NOTES AND DETAILS
	MAY 2015	
APPR	OVED:	STANDARD DRAWING NO. 3305-715

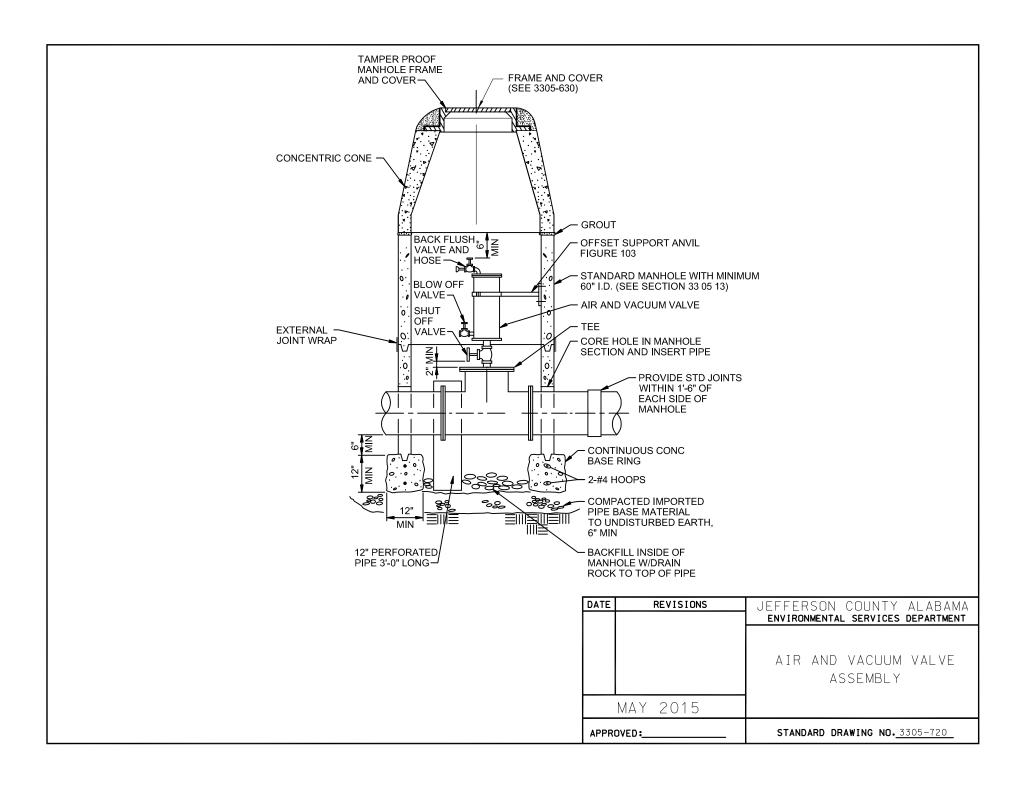

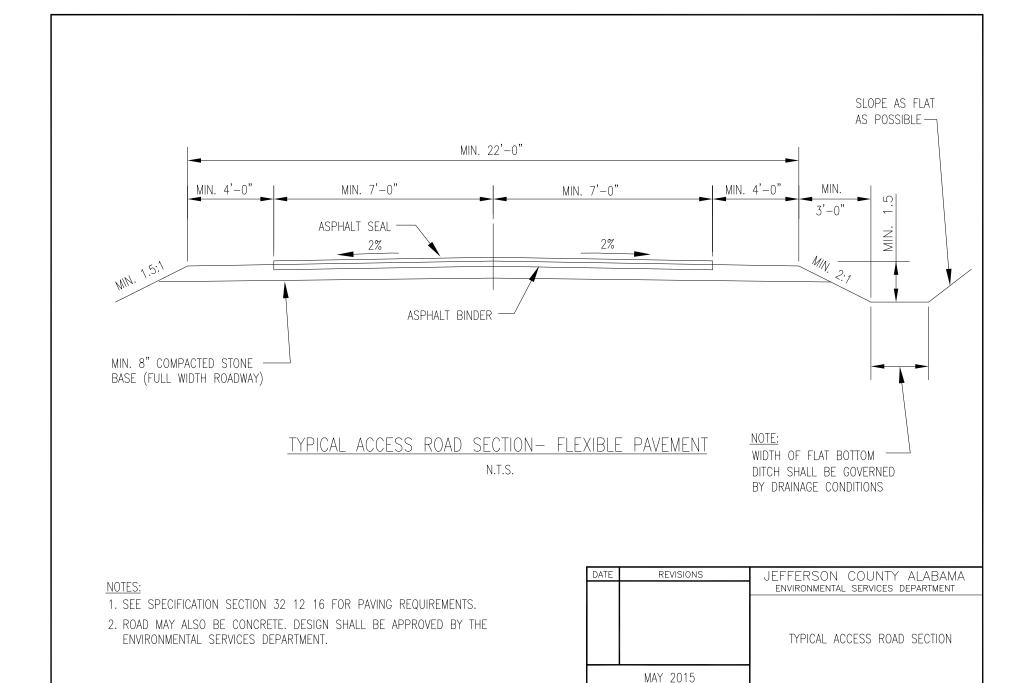


APPROVED:

STANDARD DRAWING NO. 3305-725

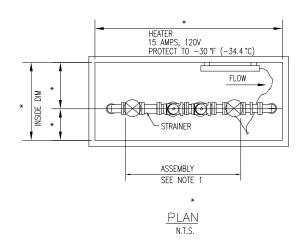

#### NOTES:


- WATTS REDUCED PRESSURE DETECTOR
   ASSEMBLY SERIES 909QT-S, OR APPROVED EQUIVALENT.
- 2. ELECTRICAL OUTLET(S) SHALL BE FOR OUTDOOR USE & INSTALLED ON A GFCI OUTLET MOUNTED A MIN. OF 2" OFF THE FLANGE FACE & 6" ABOVE THE HIGHEST POINT OF DISCHARGE.
- INSTALLATION SHALL BE MADE IN STRICT ACCORDANCE WITH LOCAL UTILITY & AWWA STANDARDS

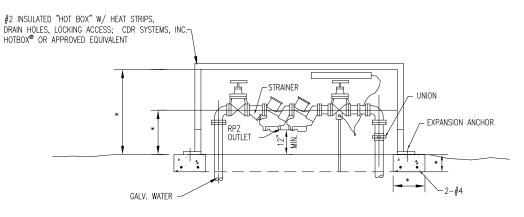

ELEVATION N.T.S.

\* SIZE TO ACCOMMODATE BACKFLOW PREVENTER


DATE	REVISIONS	JEFFERSON COUNTY ALABAMA
		ENVIRONMENTAL SERVICES DEPARTMENT
		REDUCED PRESSURE PRINCIPAL BACKFLOW PREVENTER
	MAY 2015	
APPR	OVED:	STANDARD DRAWING NO. 3305-730

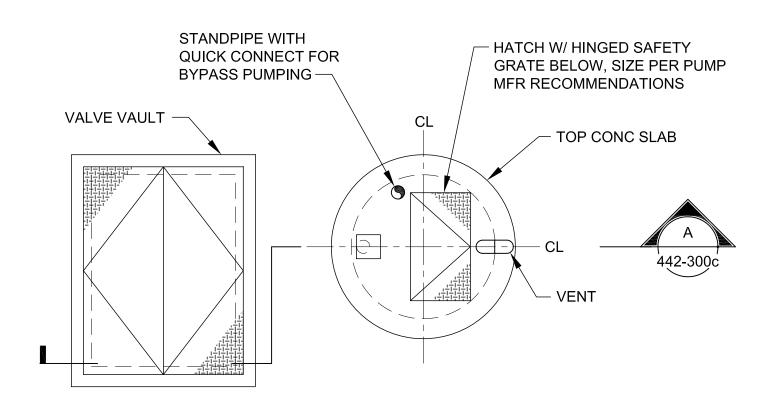

# TOP PLAN

1/4"=1'-0"

DATE	REVISIONS	JEFFERSON COUNTY ALABAMA
		ENVIRONMENTAL SERVICES DEPARTMENT
		WASTE WATER SUBMERSIBLE LIFT STATION TOP PLAN
	OCT 2013	
APPR	OVED:	STANDARD DRAWING NO. 3305-765A

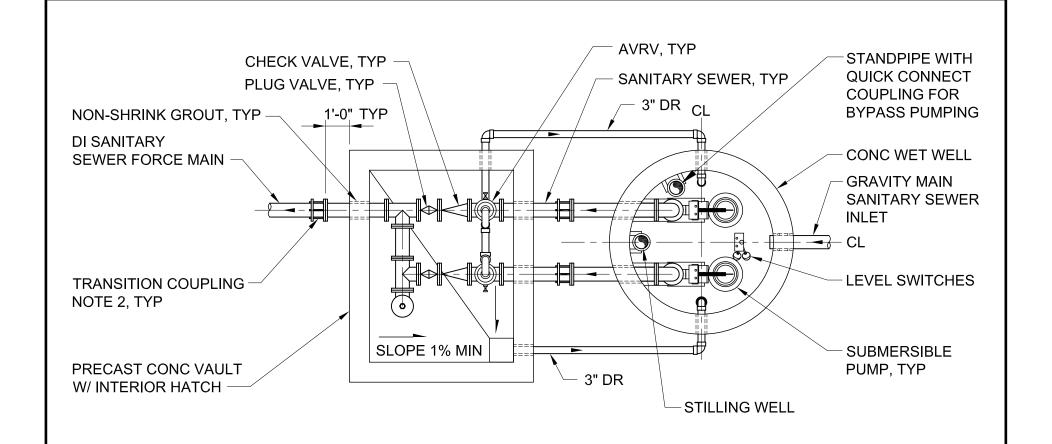

## FOUNDATION PLAN

1/4"=1'-0"

### NOTES:

- 1. THIS IS A TYPICAL DETAIL FOR A SUBMERSIBLE TYPE PUMP LIFT STATION TO BE USED AS A DESIGN GUIDE ALONG WITH THE SPECIFICATIONS. SITE OF STRUCTURES AND PIPING WILL VARY BY LOCATION AND DESIGN / OPERATING CONDITIONS.
- 2. TRANSITION COUPLING WITH RESTRAINING RODS AND CLAMPS, ROMAC SERIES 600 OR EQUAL.

F	DATE	REVISIONS	JEFFERSON COUNTY ALABAMA ENVIRONMENTAL SERVICES DEPARTMENT
			WASTE WATER SUBMERSIBLE LIFT STATION FOUNDATION PLAN
		OCT 2013	
	APPR	OVED:	STANDARD DRAWING NO. 3305-765B

